



700 29th STREET SOUTH No.206 AVON PLACE BIRMINGHAM, ALABAMA 35233 205.250.6161 barrettarchstudio.com

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(vicinity map)

Sheet Number	Sheet Name
A0.0	Title
A0.1	General Notes
A0.2	Partition Schedule
A0.3	Life Safety
A1.0	Site Plan
A1.1	Floor Plan Building 1
A1.2	Floor Plan Building 2 & 3
A1.3	Roof Plan Building 1
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A3.1	Exterior Elevations
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A6.2	3D Views

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A6.2	3D Views				

Sheet List

DESIGN SCHEMATIC

REVISIONS DATE PROJECT NUMBER SHEET TITLE

Title

Revision Schedule

Revision Revision
Date Number

10.20.2017

17-041

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LEGENDS INDICATES SECTION NUMBER INDICATES DRAWING SHEET ON WHICH SECTION IS SHOWN INDICATES SECTION NUMBER INDICATES DRAWING SHEET ON WHICH **DETAIL IS SHOWN**

INDICATES DRAWING NUMBER ON SHEET INTERIOR **ELEVATION** KFY INDICATES DRAWING SHEET ON WHICH

ELEVATION IS SHOWN €6 **EXTERIOR** INDICATES DRAWING * ELEVATION NUMBER ON SHEET KEY **INDICATES DRAWING** SHEET ON WHICH **ELEVATION IS SHOWN**

MATERIALS LEGEND				
	EARTH			
	POROUS FILL			
4 4 4 4	CONCRETE			
	RIGID INSULATION			
	CONCRETE MASONRY			
	BRICK			
	STUD PARTITION (WOOD OR METAL)			
	WOOD BLOCKING OR END SECTION			
	WOOD (FINISH)			

PLYWOOD

BATT INSULATION

GENERAL NOTES

1. CONDITIONS AND DIMENSIONS - DO NOT SCALE DRAWINGS. THE CONTRACTOR SHALL FIELD VERIFY ALL DIMENSIONS, CHECK ALL DIMENSIONS AND OTHER IRREGULARITIES PRIOR TO BEGINNING CONSTRUCTION, FABRICATING OR ORDERING ANY MATERIALS. REPORT ANY IRREGULARITIES OR DISCREPANCIES TO ARCHITECT IMMEDIATELY AND ADJUST WORK AS DIRECTED BY ARCHITECT. ANY CHANGES TO THE SCOPE OF THE WORK OR PROJECT SCHEDULE RESULTING FROM DISCREPANCIES BETWEEN THE DRAWINGS AND EXISTING CONDITIONS SHALL BE AGREED TO BY THE OWNER, CONTRACTOR, AND ARCHITECT PRIOR TO PROCEEDING WITH THE WORK.

2. SUBCONTRACTORS ARE REQUIRED TO REVIEW THE ENTIRE SET OF CONTRACT DOCUMENTS TO NOTE AREAS OF WORK OF THEIR TRADE ON SHEETS TRADITIONALLY KNOWN AS WORK OF OTHER TRADES (I.E. THE REQUIREMENTS OF PROVIDING POWER TO MECHANICAL OR OTHER EQUIPMENT SHOWN ELSEWHERE IN THE CONTRACT DOCUMENTS & NOT ON THE ELECTRICAL DRAWINGS). THE ARCHITECT IS TO BE NOTIFIED IN WRITING OF ANY DISCREPANCY AND WILL COORDINATE DESIGN WORK OF THESE ITEMS. THE SUBCONTRACTOR IS RESPONSIBLE FOR IDENTIFYING AND INCLUDING THIS IN HIS WORK CONTRACT.

3. LAYOUT ALL WALLS WITH PERMANENT MARKINGS, FOR REVIEW AND ADJUSTMENT BY ARCHITECT BEFORE INSTALLING ANY NEW WORK.

4. PRESSURIZED LINES, DRAINS, ETC...WHICH PENETRATE EXISTING OR IN-PLACE MASONRY WALLS SHALL BE INSTALLED BY CORE DRILLING. NO CHIPPING OF MASONRY WALLS WILL BE ALLOWED. REFER TO THE ELECTRICAL AND MECHANICAL DRAWINGS.

5. MAJOR WORK FOR THIS PROJECT IS WITHIN THE DESIGNATED PROJECT SITE AREA; HOWEVER, SOME WORK EXTENDS BEYOND THE DESIGNATED LIMITS. THE CONTRACTOR SHALL COORDINATE WITH THE OWNER AND SCHEDULE THIS WORK TO PROVIDE MINIMAL DISRUPTION TO THOSE AFFECTED

6. INSTALL FURRING AROUND COLUMNS AND CHASES AS CLOSE AS POSSIBLE TO THE PIPES AND STRUCTURE.

7. CEILING UTILITY COORDINATION -INSTALL ALL ELECTRICAL AND OTHER CONDUIT TIGHT TO STRUCTURE. INSTALL CEILING GRID AND LIGHT TIE WIRES SO AS NOT TO TOUCH ANY SYSTEM COMPONENT. PROVIDE 8" MINIMUM CLEAR ZONE FOR LIGHTS AND OTHER CEILING MOUNTED ITEMS. PROVIDE A MINIMUM OF 1'-0" CLEAR ZONE ADJACENT TO ANY FIRE OR SMOKE PARTITION

8. DUCTS PASSING THROUGH FIRE AND/OR SMOKE PARTITIONS ARE TO HAVE FIRE AND/OR SMOKE DAMPERS AS REQUIRED BY THE PARTITION'S RATING AND PER CODE.

9. METAL FRAMING FOR ALL SUSPENDED GYP. BD. SOFFITS, CEILINGS, FURRING, AND OVER ALL DOORS IS TO BE SECURED TO THE STRUCTURE ABOVE AS REQUIRED FOR RIGID INSTALLATION.

10. ALL WOOD AND PLYWOOD BLOCKING AND FRAMING IS TO BE FIRE RETARDANT TREATED WOOD.

11. PIPING, DUCTWORK, ETC...LOCATED IN THE FINISHED AREAS OF THE BUILDING SHALL BE CONCEALED IN CHASES/FURRED SPACES WITH THE EXCEPTION OF PIPING IN EQUIPMENT ROOMS.

12. FIREPROOFING OF PENETRATIONS IN PARTITIONS AND FLOORS SHALL BE PER A U.L. DESIGN APPROPRIATE TO THE APPLICATION.

13. PROVIDE SEALANT AT JUNCTURE OF INTERIOR FACES OF DOOR FRAMES, VIEW WINDOW FRAMES, EXTERIOR WINDOW FRAMES, AND CASEWORK WITH ADJACENT MATERIALS EVEN THOUGH JOINT MAY NOT BE VISIBLE.

14. THE COLOR OF THE BREAK METAL AND SEALANT SHALL MATCH THE COLOR OF THE ADJACENT WINDOW, DOOR, OR STOREFRONT FRAMING.

15. THE GENERAL CONTRACTOR SHALL VERIFY THAT THE ROOFER INSTALL ROOF INSULATION SO ALL AREAS OF ROOFING DRAIN TO ROOF DRAINS AND SCUPPERS APPROPRIATELY.

16. WHERE WALL SURFACES ARE NOTED "ALIGN," THE FINISHED FACE OF NEW OR EXISTING CONSTRUCTION IS TO ALIGN WITH THE FINISHED FACE OF NEW OR EXISTING CONSTRUCTION.


COLUMN REFERENCE LINES



WINDOW DESIGNATION SEE WINDOW SCHEDULE ARCHITECTURAL LOUVER DESIGNATION SEE SCHEDULE IF APPLICABLE

PARTITION KEY (3) SEE PARTITION SCHEDULE

CEILING LEGEND

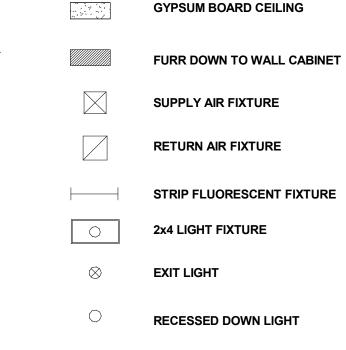



COORDINATE LOCATION OF FIXTURE WITH MECHANICAL AND ELECTRICAL

DRAWINGS. NOTIFY ARCHITECT OF

LAYOUT CONFLICTS OR DISCREPANCIES

WALL MOUNTED LIGHT FIXTURE

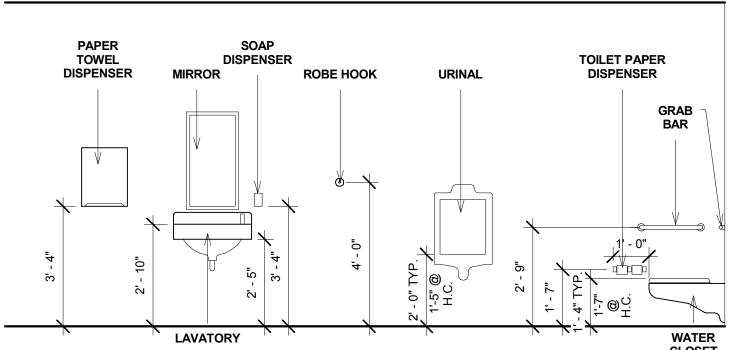

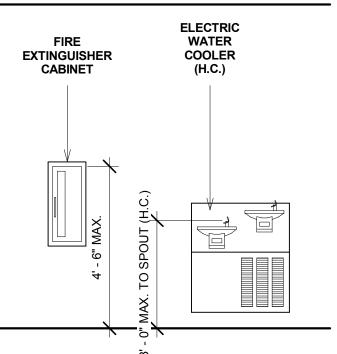

TYPICAL MOUNTING HEIGHTS UNLESS NOTED OTHERWISE

PROVIDED FOR MOUNTING HEIGHT INFORMATION ONLY. FIXTURES SHOWN ARE NOT NECESSARILY INCLUDED IN THIS PROJECT

ARCHITECTURE STUDIO

700 29th STREET SOUTH No.206 AVON PLACE **BIRMINGHAM, ALABAMA 35233** 205.250.6161

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Revision Schedule Revision Revision Date Number

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SCHEMATIC

DATE 10.20.2017

PROJECT


General Notes

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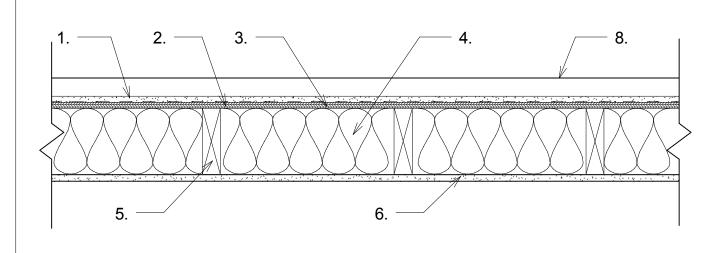
Partition Notes

- 1. PARTITIONS REQUIRED BY RATING TO EXTEND TO UNDERSIDE OF ROOF DECK SHALL HAVE THE GYPSUM BOARD CUT TO FIT ALL SURFACES WITH A 1/4" MAXIMUM TOLERANCE TO THE SHAPE OF THE DECK AND BE CONTINUOUSLY SEALED WITH APPROPRIATELY RATED SEALANT.
- 2. RATED PARTITIONS WITH ELECTRICAL OUTLETS, SWITCH BOXES, TELEPHONE BOXES, AND OTHER SIMILAR DEVICES SHALL HAVE THE GYPSUM BOARD CUT TO WITHIN A 1/8" TOLERANCE AND SHALL BE CONTINUOUSLY SEALED WITH APPROPRIATELY RATED SEALANT.
- 3. ALL PENETRATIONS THROUGH RATED WALLS (INCLUDING DUCTS, PIPES, CONDUIT, ETC.) SHALL HAVE ALL GYPSUM SURFACES CUT TO WITHIN A 1/4" MAXIMUM TOLERANCE AND SHALL BE CONTINUOUSLY SEALED WITH APPROPRIATELY RATED SEALANT.
- 4. THE BOTTOM EDGE OF ALL GYPSUM BOARD SURFACES ON RATED WALLS SHALL BE PLACED TO WITHIN 1/4" OF THE UNFINISHED FLOOR SURFACE AND SHALL BE CONTINUOUSLY SEALED WITH APPROPRIATELY RATED SEALANT.
- 5. CONTRACTOR SHALL STENCIL RATING ON WALLS ABOVE CEILING. STENCILING SHALL BE A MINIMUM OF 4" HIGH LETTERING. DESIGNATE THE SPECIFIED RATING OF THE PARTITION AND BE PLACED AT AN INCREMENT EASILY LOCATED DURING INSPECTION.




- 1. BRICK VENEER
- 2. ADJUSTABLE MASONRY ANCHORS AT EACH STUD AND AT 16" 0.C. VERTICAL.
- 3. WEATHER RESISTANT SHEATHING PAPER (SEE SPECS SECTION 06160)
- 4. WOOD STRUCTURAL PANEL SHEATHING 1/2" THICK, 4' WIDE PLYWOOD SHEATHING. INSTALLED WITH FACE GRAIN OF PLYWOOD PARALLEL WITH OR PERPENDICULAR TO STUDS. VERTICAL JOINTS CENTERED ON STUDS. HORIZONTAL JOINTS BACKED WITH NOM. 2X4 WOOD BLOCKING. ATTACHED TO STUDS ON EXTERIOR SIDE OF WALL WITH 6D CEMENT FOATED BOX NAILS SPACED 6" 0.C. AT PERIMETER OF PANELS AND 12" O.C. ALONG INTERIOR STUDS.
- 5. 6" METAL STUDS, 18 GA. MINIMUM 16" O.C., SEE SPECIFICATIONS FOR ADDITIONAL INFORMATION.
- 6. BATTS & BLANKETS MINERAL WOOL INSULATION, COMPLETELY FILLING STUD CAVITY; MIN. R-19.
- 7. 5/8" GYPSUM BOARD, SCREW ATTACHED TO METAL STUDS.

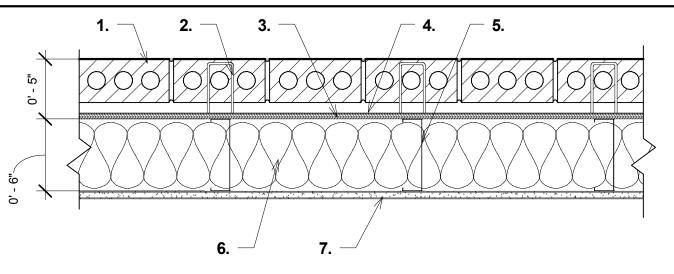E1 - BRICK AND LOAD BEARING 6" METAL STUD WALL




- 1. FIBER-CEMENT SIDING (SEE SPECIFICATION SECTION 07460)
- 2. WEATHER RESISTANT SHEATHING PAPER (SEE SPECS SECTION 06160)
- 3. WOOD STRUCTURAL PANEL SHEATHING 1/2" THICK, 4' WIDE PLYWOOD SHEATHING. INSTALLED WITH FACE GRAIN OF PLYWOOD PARALLEL WITH OR PERPENDICULAR TO STUDS. VERTICAL JOINTS CENTERED ON STUDS. HORIZONTAL JOINTS BACKED WITH NOM. 2X4 WOOD BLOCKING. ATTACHED TO STUDS ON EXTERIOR SIDE OF WALL WITH 6D CEMENT FOATED BOX NAILS SPACED 6" 0.C. AT PERIMETER OF PANELS AND 12" O.C. ALONG INTERIOR STUDS.
- 4. BATTS & BLANKETS MINERAL WOOL INSULATION, COMPLETELY FILLING STUD CAVITY; MIN. R-19..
- 5. 2X6 WOOD STUDS @ 16" O.C. WITH TWO 2x6 TOP AND ONE 2x6 BOTTOM PLATES; STUDS LATERALL-BRACED BY WOOD STRUCTURAL PANEL SHEATHING (ITEM 3).
- 6. 5/8" GYPSUM BOARD, 4' WIDE, APPLIED VERTICALLY AND ATTACHED TO STUDS AND BEARING PLATES WITH 1 1/4" LONG TYPE W COARSE THREAD GYPSUM PANEL STEEL SCREWS SPACED A MAX. 8" O.C., WITH LAST SCREW 1" FROM EDGE OF BOARD.
- 7. JOINTS & NAILHEADS (NOT SHOWN) WALLBOARD JOINTS COVERED WITH TAPE AND JOINT COMPOUND. NAIL HEADS COVERED WITH JOINT COMPOUND.
- 8. RAINSCREEN METAL PANELS; SEE DETAILS
- E4 1-HOUR CEMENT BOARD AND LOAD BEARING 2x6 WOOD STUD WALL (DESIGN NO. UL356) (AT RAINSCREEN)

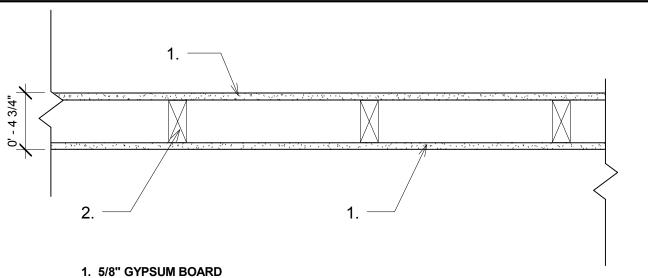


2. 2x4 WOOD STUDS @ 16" O.C.

P1 - NON-RATED 2x4 WOOD STUD WALL

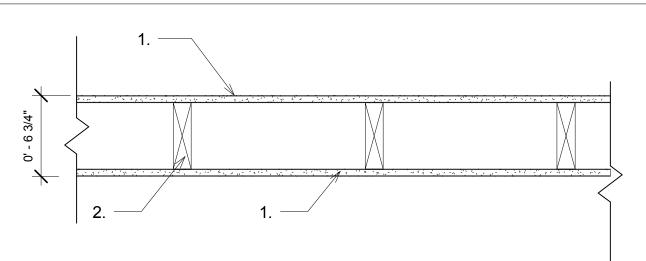

- 1. 5/8" GYPSUM BOARD.
- 2. 2X6 WOOD STUDS @ 16" O.C.

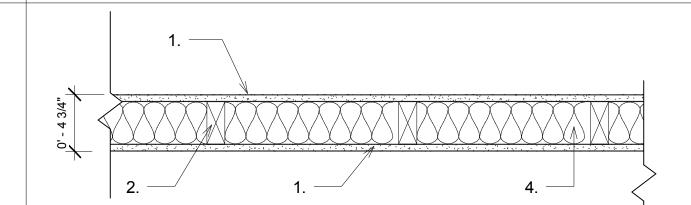


- 1. 5/8" GYPSUM BOARD WITH BEVELED, SQUARE OR TAPERED EDGES, APPLIED EITHER HORIZONTALLY OR VERTICALLY. GYPSUM PANELS FASTENED TO FRAMING WITH 1 1/4" LONG TYPE W COARSE THREAD GYPSUM PANEL STEEL SCREWS SPACED A MAX 8"O.C., WITH LAST SCREW 1" FROM EDGE OF BOARD. WHEN USED IN WIDTHS OTHER THAN 48", PANELS ARE TO BE INSTALLED HORIZONTALLY.
- 2. 2X4 WOOD STUDS @ 16" O.C., EFFECTIVELY FIRESTOPPED.
- 3. JOINTS & NAIL HEADS (NOT SHOWN) EXPOSED OR COVERED WITH FIBER TAPE & JOINT COMPOUND, EXCEPT WHERE REQUIRED FOR SPECIFIC EDGE CONFIGURATION. FOR TAPERED, ROUNDED EDGE GYPSUM BOARD, JOINTS COVERED WITH JOINT COMPOUND OR FIBER TAPE AND JOINT COMPOUND. NAILHEADS EXPOSED OR COVERED WITH JOINT COMPOUND.
- 4. BATTS & BLANKETS MINERAL WOOL INSULATION, PARTIALLY OR COMPLETELY FILLING STUD CAVITY: 3" MINERAL FIBER, 2.5 PCF.,

UL DESIGN No. U305

- 1. 5/8" GYPSUM BOARD, 2 LAYERS, APPLIED EITHER HORIZONTALLY OR VERTICALLY. INNER LAYERS ATTACHED TO STUDS WITH 1 7/8" NAILS SPACED 6"O.C.. OUTER LAYER ATTACHED TO STUDS OVER INNER LAYER WITH 2 3/8" LONG NAILS SPACED 8"O.C. VERTICAL JOINTS LOCATED OVER STUDS. ALL JOINTS IN FACE LAYERS STAGGERED WITH JOINTS IN BASE LAYERS. JOINTS OF EACH BASE LAYER OFFSET WITH JOINTS OF BASE LAYER ON OPPOSITE SIDE. WHEN WIDTHS OTHER THAN 48", GYP. BD. TO BE INSTALLED HORIZONTALLY.
- 2. 2X4 WOOD STUDS @ 16" O.C., EFFECTIVELY FIRESTOPPED.
- 3. JOINTS & NAIL HEADS (NOT SHOWN) EXPOSED OR COVERED WITH FIBER TAPE & JOINT COMPOUND, EXCEPT WHÈRE REQUIRED FOR SPECIFIC EDGE CONFIGURATION. FOR TAPERED, ROUNDED EDGE GYPSUM BOARD, JOINTS COVERED WITH JOINT COMPOUND OR FIBER TAPE AND JOINT COMPOUND. NAILHEADS EXPOSED OR COVERED WITH JOINT
- 4. BATTS & BLANKETS MINERAL WOOL INSULATION, PARTIALLY OR COMPLETELY FILLING STUD CAVITY: 3" MINERAL FIBER, 2.5 PCF., UNFACED.
- 5. NAILS (NOT SHOWN) 6d CEMEMNT COATED NAILS 1 7/8" LONG, 0.0915" SHANK DIAM., 1/4" DIAM. HEADS, AND 8d CEMENT COATED NAILS 2 3/8" LONG, 0.113" SHANK DIAM, 9/32"


P3 - 2-HOUR RATED 2x4 WOOD STUD WALL UL DESIGN No. 301

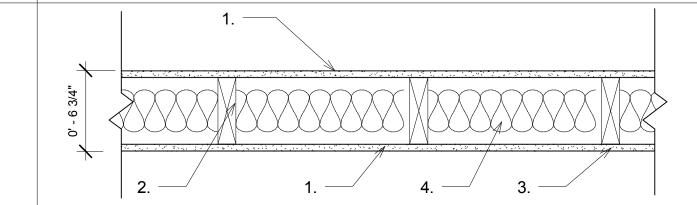

- 1. 5/8" GYPSUM BOARD WITH BEVELED, SQUARE OR TAPERED EDGES, APPLIED EITHER HORIZONTALLY OR VERTICALLY. GYPSUM PANELS FASTENED TO FRAMING WITH 1 1/4" LONG TYPE W COARSE THREAD GYPSUM PANEL STEEL SCREWS SPACED A MAX 8"O.C., WITH LAST SCREW 1" FROM EDGE OF BOARD. WHEN USED IN WIDTHS OTHER THAN 48", PANELS ARE TO BE INSTALLED HORIZONTALLY.
- 2. 2X6 WOOD STUDS @ 16" O.C., EFFECTIVELY FIRESTOPPED.
- 3. JOINTS & NAIL HEADS EXPOSED OR COVERED WITH FIBER TAPE & JOINT COMPOUND, EXCEPT WHERE REQUIRED FOR SPECIFIC EDGE CONFIGURATION. FOR TAPERED, ROUNDED EDGE GYPSUM BOARD, JOINTS COVERED WITH JOINT COMPOUND OR FIBER TAPE AND JOINT COMPOUND. NAILHEADS EXPOSED OR COVERED WITH JOINT COMPOUND.
- 4. BATTS & BLANKETS MINERAL WOOL INSULATION, PARTIALLY OR COMPLETELY FILLING STUD CAVITY: 3" MINERAL FIBER, 2.5 PCF.,


P5 - 1-HOUR 2x6 WOOD STUDS WITH SOUNDBATTS **DESIGN NO. UL305**

P4 - NON-RATED 2x6 WOOD STUD WALL

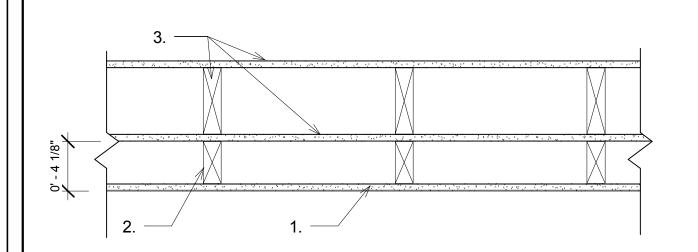

- 1. 5/8" GYPSUM BOARD
- 2. 2x4 WOOD STUDS @ 16" O.C.
- 3. WALL OF OTHER TYPE BEYOND

P7 - NON-RATED 2x4 WOOD STUD FURRED WALL

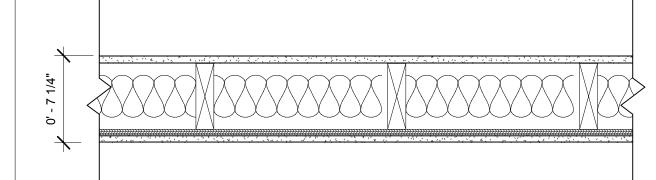

P2 - 1-HOUR RATED 2x4 WOOD STUD WALL

- FIRESTOPPED TOP & BOTTOM.
- 2. WOOD STRUCTURAL PANEL SHEATHING NOM 15/32" THICK, 4' WIDE APA RATED SHEATHING PLYWOOD. INSTALLED WITH FACE GRAIN OF PLYWOOD PARALLEL WITH STUDS. VERTICAL JOINTS CENTERED ON STUDS, AND STAGGERED ONE STUD SPACE FROM WALLBOARD JOINTS. HORIZONTAL JOINTS BACKED WITH NOM 2x4 WOOD BACKING. ATTACHED TO STUDS ON EXTERIOR SIDE OF WALL WITH 6D CEMENT COATED STEEL BOX NAILS SPACED 12"OC ALONG INTERIOR STUDS AND 6"OC AT
- 4. GYPSUM BOARD 5/8" THICK, 4 FT WIDE. ATTACHED THROUGH PLYWOOD WITH 8D CEMENT COATED NAILS 2 3/8" LONG, 0.113" SHANK DIAM, 9/32" DIAM HEAD NAILS
- 5. GYPSUM BOARD 5/8" THICK, 4 FT WIDE. ATTACHED TO STUDS OR BLOCKING AT

P13 - 1-HOUR SHEAR WALL, 2x6 WOOD STUDS WITH SOUNDBATTS



1. WOOD STUDS - NOM 2x4 SPACED 24"OC, LATERALLY BRACED, AND EFFECTIVELY

- PERIMETER OF PANELS. 3. BATTS & BLANKETS - 3 1/2" THICK FOIL FACED GLASS FIBER BATTS.
- SPACED 7"OC ALONG STUDS AND AT PERIMETER OF PANELS.
- 7"OC WITH 6D CEMENT COATED NAILS, 1 7/8" LONG, .0915" SHANK DIAM AND 1/4"

DESIGN NO. UL344

Revision Schedule Revision Revision Date Number SIGN

REVISIONS

DE

SCHEMATIC

DATE PROJECT NUMBER

Partition Schedule

10.20.2017

A0.2

17-041

NUMBER

PM: Author CB: Checker

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700 29th STREET SOUTH

No.206 AVON PLACE

NOTE: SCOPE IS FOR SHELL BUILDING. TENANT BUILD-OUT WILL BE UNDER SEPARATE PERMITS

BUILDING CODE COMPLIANCE DATA | 2015 IBC

LABAMA			
ГЕМ	REFERENCE	ALLOWED/REQUIRED	PROVIDED
OCCUPANCY	IBC CHAPTER 3	A-2 (2700sf), B (4570sf), M (2100 sf)	A-2 is most restrictive
YPE OF CONSTRUCTION FOR THIS BUILDING	IBC CHAPTER 6	Type V B	Type V B
BUILDING AREA (Square Feet)	IBC TABLE 506.2	24,000 sq. ft.	9,970 sq. ft.
	IDO INDEE COC.E	24,000 54. 16.	
IEW BUILDING OR EXISTING BUILDING?	IDC 000 0 1 0	Described assess the a 100 Occurrents	NEW
UTOMATIC SPRINKLER PROTECTION	IBC 903.2.1.2	Required - more than 100 Occupants	YES
	CONTRACTOR OF THE PROPERTY OF		
OCCUPANT LOAD, BY FLOOR	IBC TABLE 1004.1.2		
irst Floor (Occupants)			
Tenant 101 (A-2)	15 sf / p (dining) and 200 sf / p (kitchen)	1882 sf / 15 and 830 sf / 200	131
Tenant 102 (B)	100 sf / p	1100 sf / 100	11
		Processing and the second seco	
Tenant 103 (B)	100 sf / p	1466 sf / 100	15
Tenant 104 (M)	60 sf / p	2001 sf / 60	34
Tenant 105 (M)	60 sf / p	2111 sf / 60	36
TOTAL OCCUPANTS			227
BUILDING HEIGHT AND AREA	IBC CHAPTER 5		
		Time V P	Time V P
YPE CONSTRUCTION FOR THIS BUILDING	IBC CHAPTER 6	Type V B	Type V B
>STORIES	IBC TABLE 504.4	1	1
>HEIGHT OF ROOF STRUCTURE (DEPENDING ON COMBUSTIBLE OR	IBC TABLE 504.3	40'	29'
ION COMBUSTIBLE MATERIAL			
>ALLOWABLE AREA	SEE ABOVE FOR 506.2 DATA.		
CONSTRUCTION	IDO TARI E COS 1	A/D I A/A	
OCCUPANCY SEPARATION	IBC TABLE 508.4	A/B and A/M requires 1 Hour	1 Hour between A/B or A/M
XTERIOR BEARING WALLS	IBC TABLE 601	0	0
NTERIOR BEARING WALLS	IBC TABLE 601	0	0
XTERIOR NON BEARING WALLS	IBC TABLE 602	0	0
NTERIOR NON BEARING WALLS & PARTITIONS	IBC TABLE 601	0	0
IRE RATING OF COLUMNS	IBC TABLE 601	0	0
IRE RATING OF BEAMS	IBC TABLE 601	0	0
IRE RATING OF FLOOR AND CEILING	IBC TABLE 601	0	0
MINIMUM CLASSIFICATION OF ROOF COVERING	IBC TABLE 1505.1	С	C
XTERIOR WALL WITHIN 5' OF COMMON PROPERTY LINE	IBC TABLE 602	0	N/A
IRE PROTECTION SYSTEMS			
	IDC 000	DECLUDED	PROVIDED
UTOMATIC SPRINKLER PROTECTION	IBC 903	REQUIRED	PROVIDED
ORTABLE FIRE EXTINGUISHERS	IBC 906 & IFC	REQUIRED	PROVIDED
>Minimum rated single extinguisher	IBC TABLE 906.3(1)	2-A	2-A
>Maximum floor area per unit of A (sq. ft.)	IBC TABLE 906.3(1)	3,000 sq ft	5,902 sq. ft. (>3,000 sq. ft.)
CONTROL OF THE PROPERTY OF THE	I DECORA DEGENERATION MEDICALES	300 00 00 00 00 00 00 00 00 00 00 00 00	
>Maximum floor area per extinguisher (sq. ft.)	IBC TABLE 906.3(1)	11,250 sq ft	5,902 sq. ft. (< 11,250 sq. ft.)
>Maximum travel distance to any extinguisher (feet)	IBC TABLE 906.3(1)	75 feet	75 feet
>Gross weight of extinguishers selected	NFPA 10 1-6.10	Not exceeding 40 lbs	
>Installation height to top of unit from floor (inches)	NFPA 10 1-6.10	No more than 60"	
IRE ALARM DETECTION SYSTEMS	IBC 907	NOT REQUIRED	NOT PROVIDED
THE ABARM BETEGRIOR OTOTEMO	150 007	NOTTEGORIED	NOTTHOUBED
MEANS OF EGRESS	IBC CHAPTER 10		
ACCLIDANCY (Occupants)			
OCCUPANCY (Occupants)			227
IUMBER OF EXITS ALLOWED	IBC 1006.3.1	2 EXITS FOR 101, 1 EXIT FOR 102-105	227 2 EXITS FOR 101, 1 EXIT FOR 102-015
IUMBER OF EXITS ALLOWED	IBC 1006.3.1 IBC TABLE 1017.2	2 EXITS FOR 101, 1 EXIT FOR 102-105 200'	THE SUPPLY WERE STREET OF THE PARTY OF THE P
IUMBER OF EXITS ALLOWED ILLOWABLE DISTANCE OF TRAVEL TO AN EXIT (feet)	IBC TABLE 1017.2	200'	2 EXITS FOR 101, 1 EXIT FOR 102-015 < 200'
JUMBER OF EXITS ALLOWED ALLOWABLE DISTANCE OF TRAVEL TO AN EXIT (feet) CORRIDOR FIRE RESISTANCE RATING	IBC TABLE 1017.2 IBC TABLE 1020.1	200' 1 HR over 30 occupants	2 EXITS FOR 101, 1 EXIT FOR 102-015 < 200' Provided
JUMBER OF EXITS ALLOWED ALLOWABLE DISTANCE OF TRAVEL TO AN EXIT (feet) CORRIDOR FIRE RESISTANCE RATING DEAD END CORRIDORS	IBC TABLE 1017.2 IBC TABLE 1020.1 IBC 1020.4	200' 1 HR over 30 occupants 20 or Length less than 2.5 x Width.	2 EXITS FOR 101, 1 EXIT FOR 102-015 < 200'
JUMBER OF EXITS ALLOWED ALLOWABLE DISTANCE OF TRAVEL TO AN EXIT (feet) CORRIDOR FIRE RESISTANCE RATING	IBC TABLE 1017.2 IBC TABLE 1020.1	200' 1 HR over 30 occupants 20 or Length less than 2.5 x Width. 0.2"	2 EXITS FOR 101, 1 EXIT FOR 102-015 < 200' Provided no dead end corridors
JUMBER OF EXITS ALLOWED ALLOWABLE DISTANCE OF TRAVEL TO AN EXIT (feet) CORRIDOR FIRE RESISTANCE RATING DEAD END CORRIDORS	IBC TABLE 1017.2 IBC TABLE 1020.1 IBC 1020.4	200' 1 HR over 30 occupants 20 or Length less than 2.5 x Width.	2 EXITS FOR 101, 1 EXIT FOR 102-015 < 200' Provided
JUMBER OF EXITS ALLOWED LLOWABLE DISTANCE OF TRAVEL TO AN EXIT (feet) CORRIDOR FIRE RESISTANCE RATING DEAD END CORRIDORS XIT DOORS	IBC TABLE 1017.2 IBC TABLE 1020.1 IBC 1020.4 IBC 1005.1 IBC 1005.1	200' 1 HR over 30 occupants 20 or Length less than 2.5 x Width. 0.2"	2 EXITS FOR 101, 1 EXIT FOR 102-015 < 200' Provided no dead end corridors
JUMBER OF EXITS ALLOWED LLOWABLE DISTANCE OF TRAVEL TO AN EXIT (feet) CORRIDOR FIRE RESISTANCE RATING DEAD END CORRIDORS EXIT DOORS SWIDTH IN INCHES OF EXIT DOORS REQUIRED SCLEAR WIDTH OF DOORS ALONG ACCESSIBLE ROUTE	IBC TABLE 1017.2 IBC TABLE 1020.1 IBC 1020.4 IBC 1005.1 IBC 1005.1 ICC/ANSI A-117.1, 404.2.3	200' 1 HR over 30 occupants 20 or Length less than 2.5 x Width. 0.2"	2 EXITS FOR 101, 1 EXIT FOR 102-015 < 200' Provided no dead end corridors 72" PROVIDED
JUMBER OF EXITS ALLOWED LLOWABLE DISTANCE OF TRAVEL TO AN EXIT (feet) CORRIDOR FIRE RESISTANCE RATING DEAD END CORRIDORS XIT DOORS >WIDTH IN INCHES OF EXIT DOORS REQUIRED >CLEAR WIDTH OF DOORS ALONG ACCESSIBLE ROUTE JUMBER OF PERSONS SERVED BY EXIT DOORS PROVIDED	IBC TABLE 1017.2 IBC TABLE 1020.1 IBC 1020.4 IBC 1005.1 IBC 1005.1 ICC/ANSI A-117.1, 404.2.3 IBC 1005.1	200' 1 HR over 30 occupants 20 or Length less than 2.5 x Width. 0.2" 50"	2 EXITS FOR 101, 1 EXIT FOR 102-015 < 200' Provided no dead end corridors 72" PROVIDED
JUMBER OF EXITS ALLOWED ALLOWABLE DISTANCE OF TRAVEL TO AN EXIT (feet) CORRIDOR FIRE RESISTANCE RATING DEAD END CORRIDORS XIT DOORS >WIDTH IN INCHES OF EXIT DOORS REQUIRED >CLEAR WIDTH OF DOORS ALONG ACCESSIBLE ROUTE JUMBER OF PERSONS SERVED BY EXIT DOORS PROVIDED GRESS ILLUMINATION	IBC TABLE 1017.2 IBC TABLE 1020.1 IBC 1020.4 IBC 1005.1 IBC 1005.1 ICC/ANSI A-117.1, 404.2.3 IBC 1005.1 IBC 1008.2	200' 1 HR over 30 occupants 20 or Length less than 2.5 x Width. 0.2" 50"	2 EXITS FOR 101, 1 EXIT FOR 102-015 < 200' Provided no dead end corridors 72" PROVIDED 360 Provided
JUMBER OF EXITS ALLOWED LLOWABLE DISTANCE OF TRAVEL TO AN EXIT (feet) CORRIDOR FIRE RESISTANCE RATING DEAD END CORRIDORS XIT DOORS >WIDTH IN INCHES OF EXIT DOORS REQUIRED >CLEAR WIDTH OF DOORS ALONG ACCESSIBLE ROUTE JUMBER OF PERSONS SERVED BY EXIT DOORS PROVIDED	IBC TABLE 1017.2 IBC TABLE 1020.1 IBC 1020.4 IBC 1005.1 IBC 1005.1 ICC/ANSI A-117.1, 404.2.3 IBC 1005.1	200' 1 HR over 30 occupants 20 or Length less than 2.5 x Width. 0.2" 50" Illuminate at all times No less than 1 foot-candle (11 lux) at the	2 EXITS FOR 101, 1 EXIT FOR 102-015 < 200' Provided no dead end corridors 72" PROVIDED
JUMBER OF EXITS ALLOWED ALLOWABLE DISTANCE OF TRAVEL TO AN EXIT (feet) CORRIDOR FIRE RESISTANCE RATING DEAD END CORRIDORS EXIT DOORS SWIDTH IN INCHES OF EXIT DOORS REQUIRED SCLEAR WIDTH OF DOORS ALONG ACCESSIBLE ROUTE JUMBER OF PERSONS SERVED BY EXIT DOORS PROVIDED GRESS ILLUMINATION SEGRESS ILLUMINATION AT FLOOR LEVEL	IBC TABLE 1017.2 IBC TABLE 1020.1 IBC 1020.4 IBC 1005.1 IBC 1005.1 ICC/ANSI A-117.1, 404.2.3 IBC 1005.1 IBC 1008.2 IBC 1008.2.1	200' 1 HR over 30 occupants 20 or Length less than 2.5 x Width. 0.2" 50" Illuminate at all times No less than 1 foot-candle (11 lux) at the walking surface.	2 EXITS FOR 101, 1 EXIT FOR 102-015 < 200' Provided no dead end corridors 72" PROVIDED 360 Provided > 1 fc
JUMBER OF EXITS ALLOWED ALLOWABLE DISTANCE OF TRAVEL TO AN EXIT (feet) CORRIDOR FIRE RESISTANCE RATING DEAD END CORRIDORS XIT DOORS >WIDTH IN INCHES OF EXIT DOORS REQUIRED >CLEAR WIDTH OF DOORS ALONG ACCESSIBLE ROUTE JUMBER OF PERSONS SERVED BY EXIT DOORS PROVIDED GRESS ILLUMINATION	IBC TABLE 1017.2 IBC TABLE 1020.1 IBC 1020.4 IBC 1005.1 IBC 1005.1 ICC/ANSI A-117.1, 404.2.3 IBC 1005.1 IBC 1008.2	200' 1 HR over 30 occupants 20 or Length less than 2.5 x Width. 0.2" 50" Illuminate at all times No less than 1 foot-candle (11 lux) at the	2 EXITS FOR 101, 1 EXIT FOR 102-015 < 200' Provided no dead end corridors 72" PROVIDED 360 Provided > 1 fc
JUMBER OF EXITS ALLOWED ALLOWABLE DISTANCE OF TRAVEL TO AN EXIT (feet) CORRIDOR FIRE RESISTANCE RATING DEAD END CORRIDORS EXIT DOORS SWIDTH IN INCHES OF EXIT DOORS REQUIRED SCLEAR WIDTH OF DOORS ALONG ACCESSIBLE ROUTE JUMBER OF PERSONS SERVED BY EXIT DOORS PROVIDED GRESS ILLUMINATION SEGRESS ILLUMINATION AT FLOOR LEVEL SEMERGENCY POWER	IBC TABLE 1017.2 IBC TABLE 1020.1 IBC 1020.4 IBC 1005.1 IBC 1005.1 ICC/ANSI A-117.1, 404.2.3 IBC 1008.2 IBC 1008.2.1 IBC 1008.3	200' 1 HR over 30 occupants 20 or Length less than 2.5 x Width. 0.2" 50" Illuminate at all times No less than 1 foot-candle (11 lux) at the walking surface. Provide power for a duration of no less than 90 min. and consist of storage batteries/equip./generator.	2 EXITS FOR 101, 1 EXIT FOR 102-015 < 200' Provided no dead end corridors 72" PROVIDED 360 Provided > 1 fc Battery pack.
JUMBER OF EXITS ALLOWED JUMBER OF EXITS ALLOWED JUMBER OF EXITS ALLOWED JUMBER OF ERESISTANCE RATING JUMBER OF IRE RESISTANCE RATING JUMBER OF CORRIDORS JUMBER OF EXIT DOORS REQUIRED JUMBER OF PERSONS SERVED BY EXIT DOORS PROVIDED JUMBER OF PERSONS BY EXIT DOORS PROVIDED	IBC TABLE 1017.2 IBC TABLE 1020.1 IBC 1020.4 IBC 1005.1 IBC 1005.1 ICC/ANSI A-117.1, 404.2.3 IBC 1008.2 IBC 1008.2.1 IBC 1008.3 IBC 1008.3	200' 1 HR over 30 occupants 20 or Length less than 2.5 x Width. 0.2" 50" Illuminate at all times No less than 1 foot-candle (11 lux) at the walking surface. Provide power for a duration of no less than 90 min. and consist of storage batteries/ equip./generator. Exit signs are not required in rooms or areas that require only one exit or exit access.	2 EXITS FOR 101, 1 EXIT FOR 102-015 < 200' Provided no dead end corridors 72" PROVIDED 360 Provided > 1 fc Battery pack.
JUMBER OF EXITS ALLOWED ALLOWABLE DISTANCE OF TRAVEL TO AN EXIT (feet) CORRIDOR FIRE RESISTANCE RATING DEAD END CORRIDORS EXIT DOORS SWIDTH IN INCHES OF EXIT DOORS REQUIRED SCLEAR WIDTH OF DOORS ALONG ACCESSIBLE ROUTE JUMBER OF PERSONS SERVED BY EXIT DOORS PROVIDED GRESS ILLUMINATION SEGRESS ILLUMINATION AT FLOOR LEVEL SEMERGENCY POWER	IBC TABLE 1017.2 IBC TABLE 1020.1 IBC 1020.4 IBC 1005.1 IBC 1005.1 ICC/ANSI A-117.1, 404.2.3 IBC 1008.2 IBC 1008.2.1 IBC 1008.3	200' 1 HR over 30 occupants 20 or Length less than 2.5 x Width. 0.2" 50" Illuminate at all times No less than 1 foot-candle (11 lux) at the walking surface. Provide power for a duration of no less than 90 min. and consist of storage batteries/ equip./generator. Exit signs are not required in rooms or areas	2 EXITS FOR 101, 1 EXIT FOR 102-015 < 200' Provided no dead end corridors 72" PROVIDED 360 Provided > 1 fc Battery pack.
JUMBER OF EXITS ALLOWED JUMBER OF EXITS ALLOWED JUMBER OF EXITS ALLOWED JUMBER OF ERESISTANCE RATING JUMBER OF IRE RESISTANCE RATING JUMBER OF CORRIDORS JUMBER OF EXIT DOORS REQUIRED JUMBER OF PERSONS SERVED BY EXIT DOORS PROVIDED JUMBER OF PERSONS BY EXIT DOORS PROVIDED	IBC TABLE 1017.2 IBC TABLE 1020.1 IBC 1020.4 IBC 1005.1 IBC 1005.1 ICC/ANSI A-117.1, 404.2.3 IBC 1008.2 IBC 1008.2.1 IBC 1008.3 IBC 1008.3	200' 1 HR over 30 occupants 20 or Length less than 2.5 x Width. 0.2" 50" Illuminate at all times No less than 1 foot-candle (11 lux) at the walking surface. Provide power for a duration of no less than 90 min. and consist of storage batteries/ equip./generator. Exit signs are not required in rooms or areas that require only one exit or exit access.	2 EXITS FOR 101, 1 EXIT FOR 102-015 < 200' Provided no dead end corridors 72" PROVIDED 360 Provided > 1 fc Battery pack.
JUMBER OF EXITS ALLOWED ALLOWABLE DISTANCE OF TRAVEL TO AN EXIT (feet) CORRIDOR FIRE RESISTANCE RATING DEAD END CORRIDORS EXIT DOORS SWIDTH IN INCHES OF EXIT DOORS REQUIRED SCLEAR WIDTH OF DOORS ALONG ACCESSIBLE ROUTE JUMBER OF PERSONS SERVED BY EXIT DOORS PROVIDED GRESS ILLUMINATION SEGRESS ILLUMINATION AT FLOOR LEVEL SEMERGENCY POWER SEXIT SIGN ACTILE EXIT SIGNS	IBC TABLE 1017.2 IBC TABLE 1020.1 IBC 1020.4 IBC 1005.1 IBC 1005.1 ICC/ANSI A-117.1, 404.2.3 IBC 1005.1 IBC 1008.2 IBC 1008.2.1 IBC 1008.3 IBC 10131.1 (EX 1) IBC 1013.5	200' 1 HR over 30 occupants 20 or Length less than 2.5 x Width. 0.2" 50" Illuminate at all times No less than 1 foot-candle (11 lux) at the walking surface. Provide power for a duration of no less than 90 min. and consist of storage batteries/ equip./generator. Exit signs are not required in rooms or areas that require only one exit or exit access.	2 EXITS FOR 101, 1 EXIT FOR 102-015 < 200' Provided no dead end corridors 72" PROVIDED 360 Provided > 1 fc Battery pack.
JUMBER OF EXITS ALLOWED ALLOWABLE DISTANCE OF TRAVEL TO AN EXIT (feet) CORRIDOR FIRE RESISTANCE RATING DEAD END CORRIDORS EXIT DOORS SWIDTH IN INCHES OF EXIT DOORS REQUIRED SCLEAR WIDTH OF DOORS ALONG ACCESSIBLE ROUTE JUMBER OF PERSONS SERVED BY EXIT DOORS PROVIDED GRESS ILLUMINATION SEGRESS ILLUMINATION AT FLOOR LEVEL SEMERGENCY POWER SEXIT SIGN ACTILE EXIT SIGNS FLUMBING PLUMBING FIXTURES TO BE PROVIDED UNDER SEPARATE PERMIT	IBC TABLE 1017.2 IBC TABLE 1020.1 IBC 1020.4 IBC 1005.1 IBC 1005.1 ICC/ANSI A-117.1, 404.2.3 IBC 1005.1 IBC 1008.2 IBC 1008.2 IBC 1008.3 IBC 10131.1 (EX 1) IBC 1013.5 Chapter 29	200' 1 HR over 30 occupants 20 or Length less than 2.5 x Width. 0.2" 50" Illuminate at all times No less than 1 foot-candle (11 lux) at the walking surface. Provide power for a duration of no less than 90 min. and consist of storage batteries/ equip./generator. Exit signs are not required in rooms or areas that require only one exit or exit access.	2 EXITS FOR 101, 1 EXIT FOR 102-015 < 200' Provided no dead end corridors 72" PROVIDED 360 Provided > 1 fc Battery pack.
JUMBER OF EXITS ALLOWED ALLOWABLE DISTANCE OF TRAVEL TO AN EXIT (feet) CORRIDOR FIRE RESISTANCE RATING JEAD END CORRIDORS EXIT DOORS SWIDTH IN INCHES OF EXIT DOORS REQUIRED SCLEAR WIDTH OF DOORS ALONG ACCESSIBLE ROUTE JUMBER OF PERSONS SERVED BY EXIT DOORS PROVIDED GRESS ILLUMINATION SEGRESS ILLUMINATION AT FLOOR LEVEL SEMERGENCY POWER SEXIT SIGN ACTILE EXIT SIGNS	IBC TABLE 1017.2 IBC TABLE 1020.1 IBC 1020.4 IBC 1005.1 IBC 1005.1 ICC/ANSI A-117.1, 404.2.3 IBC 1005.1 IBC 1008.2 IBC 1008.2.1 IBC 1008.3 IBC 10131.1 (EX 1) IBC 1013.5	200' 1 HR over 30 occupants 20 or Length less than 2.5 x Width. 0.2" 50" Illuminate at all times No less than 1 foot-candle (11 lux) at the walking surface. Provide power for a duration of no less than 90 min. and consist of storage batteries/ equip./generator. Exit signs are not required in rooms or areas that require only one exit or exit access. Comply with ICC A117.1	2 EXITS FOR 101, 1 EXIT FOR 102-015 < 200' Provided no dead end corridors 72" PROVIDED 360 Provided > 1 fc Battery pack.
JUMBER OF EXITS ALLOWED ALLOWABLE DISTANCE OF TRAVEL TO AN EXIT (feet) CORRIDOR FIRE RESISTANCE RATING DEAD END CORRIDORS EXIT DOORS SWIDTH IN INCHES OF EXIT DOORS REQUIRED SCLEAR WIDTH OF DOORS ALONG ACCESSIBLE ROUTE JUMBER OF PERSONS SERVED BY EXIT DOORS PROVIDED GRESS ILLUMINATION SEGRESS ILLUMINATION AT FLOOR LEVEL SEMERGENCY POWER SEXIT SIGN ACTILE EXIT SIGNS FLUMBING PLUMBING FIXTURES TO BE PROVIDED UNDER SEPARATE PERMIT	IBC TABLE 1017.2 IBC TABLE 1020.1 IBC 1020.4 IBC 1005.1 IBC 1005.1 ICC/ANSI A-117.1, 404.2.3 IBC 1005.1 IBC 1008.2 IBC 1008.2 IBC 1008.3 IBC 10131.1 (EX 1) IBC 1013.5 Chapter 29	200' 1 HR over 30 occupants 20 or Length less than 2.5 x Width. 0.2" 50" Illuminate at all times No less than 1 foot-candle (11 lux) at the walking surface. Provide power for a duration of no less than 90 min. and consist of storage batteries/ equip./generator. Exit signs are not required in rooms or areas that require only one exit or exit access.	2 EXITS FOR 101, 1 EXIT FOR 102-015 < 200' Provided no dead end corridors 72" PROVIDED 360 Provided > 1 fc Battery pack.
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AUMBER OF EXITS ALLOWED ALLOWABLE DISTANCE OF TRAVEL TO AN EXIT (feet) CORRIDOR FIRE RESISTANCE RATING DEAD END CORRIDORS EXIT DOORS EXIT DOORS EXIT DOORS EXIT DOORS EXIT DOORS REQUIRED EXCLEAR WIDTH OF DOORS ALONG ACCESSIBLE ROUTE FUNDER OF PERSONS SERVED BY EXIT DOORS PROVIDED EXCRESS ILLUMINATION EXERCES ILLUMINATION AT FLOOR LEVEL EXEMPLY POWER EXECUTE EXIT SIGNS FLUMBING FLUMBING FIXTURES TO BE PROVIDED UNDER SEPARATE PERMIT EXERGY CONSERVATION FROM FIXED TO SEPARATE PERMIT EXERGY CONSERVATION FROM FOR THE PROVIDED CONTINUOUS FROM FOR THE PERMIT CONTINUOUS FROM FIXED FROM FIXED FROM FROM FROM FROM FROM FROM FROM FROM	IBC TABLE 1017.2 IBC TABLE 1020.1 IBC 1020.4 IBC 1005.1 IBC 1005.1 ICC/ANSI A-117.1, 404.2.3 IBC 1005.1 IBC 1008.2 IBC 1008.2 IBC 1008.3 IBC 10131.1 (EX 1) IBC 1013.5 Chapter 29	200' 1 HR over 30 occupants 20 or Length less than 2.5 x Width. 0.2" 50" Illuminate at all times No less than 1 foot-candle (11 lux) at the walking surface. Provide power for a duration of no less than 90 min. and consist of storage batteries/ equip./generator. Exit signs are not required in rooms or areas that require only one exit or exit access. Comply with ICC A117.1 R-25ci R-38	2 EXITS FOR 101, 1 EXIT FOR 102-015 < 200' Provided no dead end corridors 72" PROVIDED 360 Provided > 1 fc Battery pack.
AUMBER OF EXITS ALLOWED ALLOWABLE DISTANCE OF TRAVEL TO AN EXIT (feet) CORRIDOR FIRE RESISTANCE RATING DEAD END CORRIDORS EXIT DOORS EXIT DOORS EXIT DOORS EXIT DOORS EXIT DOORS REQUIRED EXCLEAR WIDTH OF DOORS ALONG ACCESSIBLE ROUTE FUNDER OF PERSONS SERVED BY EXIT DOORS PROVIDED EXCRESS ILLUMINATION EXERCES ILLUMINATION AT FLOOR LEVEL EXEMPLY POWER EXECUTE EXIT SIGNS FLUMBING FLUMBING FIXTURES TO BE PROVIDED UNDER SEPARATE PERMIT EXERCY CONSERVATION FROM FIXED TOOLS AND THE PERMIT OF TRAVEL OF TRAVE	IBC TABLE 1017.2 IBC TABLE 1020.1 IBC 1020.4 IBC 1005.1 IBC 1005.1 ICC/ANSI A-117.1, 404.2.3 IBC 1005.1 IBC 1008.2 IBC 1008.2 IBC 1008.3 IBC 10131.1 (EX 1) IBC 1013.5 Chapter 29	200' 1 HR over 30 occupants 20 or Length less than 2.5 x Width. 0.2" 50" Illuminate at all times No less than 1 foot-candle (11 lux) at the walking surface. Provide power for a duration of no less than 90 min. and consist of storage batteries/ equip./generator. Exit signs are not required in rooms or areas that require only one exit or exit access. Comply with ICC A117.1 R-25ci R-38 R-13 + R3.8ci - or - R-20	2 EXITS FOR 101, 1 EXIT FOR 102-015 < 200' Provided no dead end corridors 72" PROVIDED 360 Provided > 1 fc Battery pack.
ALLOWABLE DISTANCE OF TRAVEL TO AN EXIT (feet) CORRIDOR FIRE RESISTANCE RATING DEAD END CORRIDORS EXIT DOORS EXIT DOORS EXIT DOORS EXIT DOORS EXIT DOORS REQUIRED EXIT DOORS REQUIRED EXIT DOORS REQUIRED EXIT DOORS PROVIDED EXIT SIGNS EXIT SIGN EXIT SIGN EXIT SIGNS EXIT SIG	IBC TABLE 1017.2 IBC TABLE 1020.1 IBC 1020.4 IBC 1005.1 IBC 1005.1 ICC/ANSI A-117.1, 404.2.3 IBC 1005.1 IBC 1008.2 IBC 1008.2 IBC 1008.3 IBC 10131.1 (EX 1) IBC 1013.5 Chapter 29	200' 1 HR over 30 occupants 20 or Length less than 2.5 x Width. 0.2" 50" Illuminate at all times No less than 1 foot-candle (11 lux) at the walking surface. Provide power for a duration of no less than 90 min. and consist of storage batteries/ equip./generator. Exit signs are not required in rooms or areas that require only one exit or exit access. Comply with ICC A117.1 R-25ci R-38 R-13 + R3.8ci - or - R-20 U = 0.46	2 EXITS FOR 101, 1 EXIT FOR 102-015 < 200' Provided no dead end corridors 72" PROVIDED 360 Provided > 1 fc Battery pack.
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700 29th STREET SOUTH

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NEW COMMERCIALS BUILDING FOR:
ROSS BRIDGE VILLAGE CENTER
Hoover, Alabama

Revision Schedule Revision Revision Number

REVISIONS

10.20.2017

DATE PROJECT NUMBER SHEET TITLE


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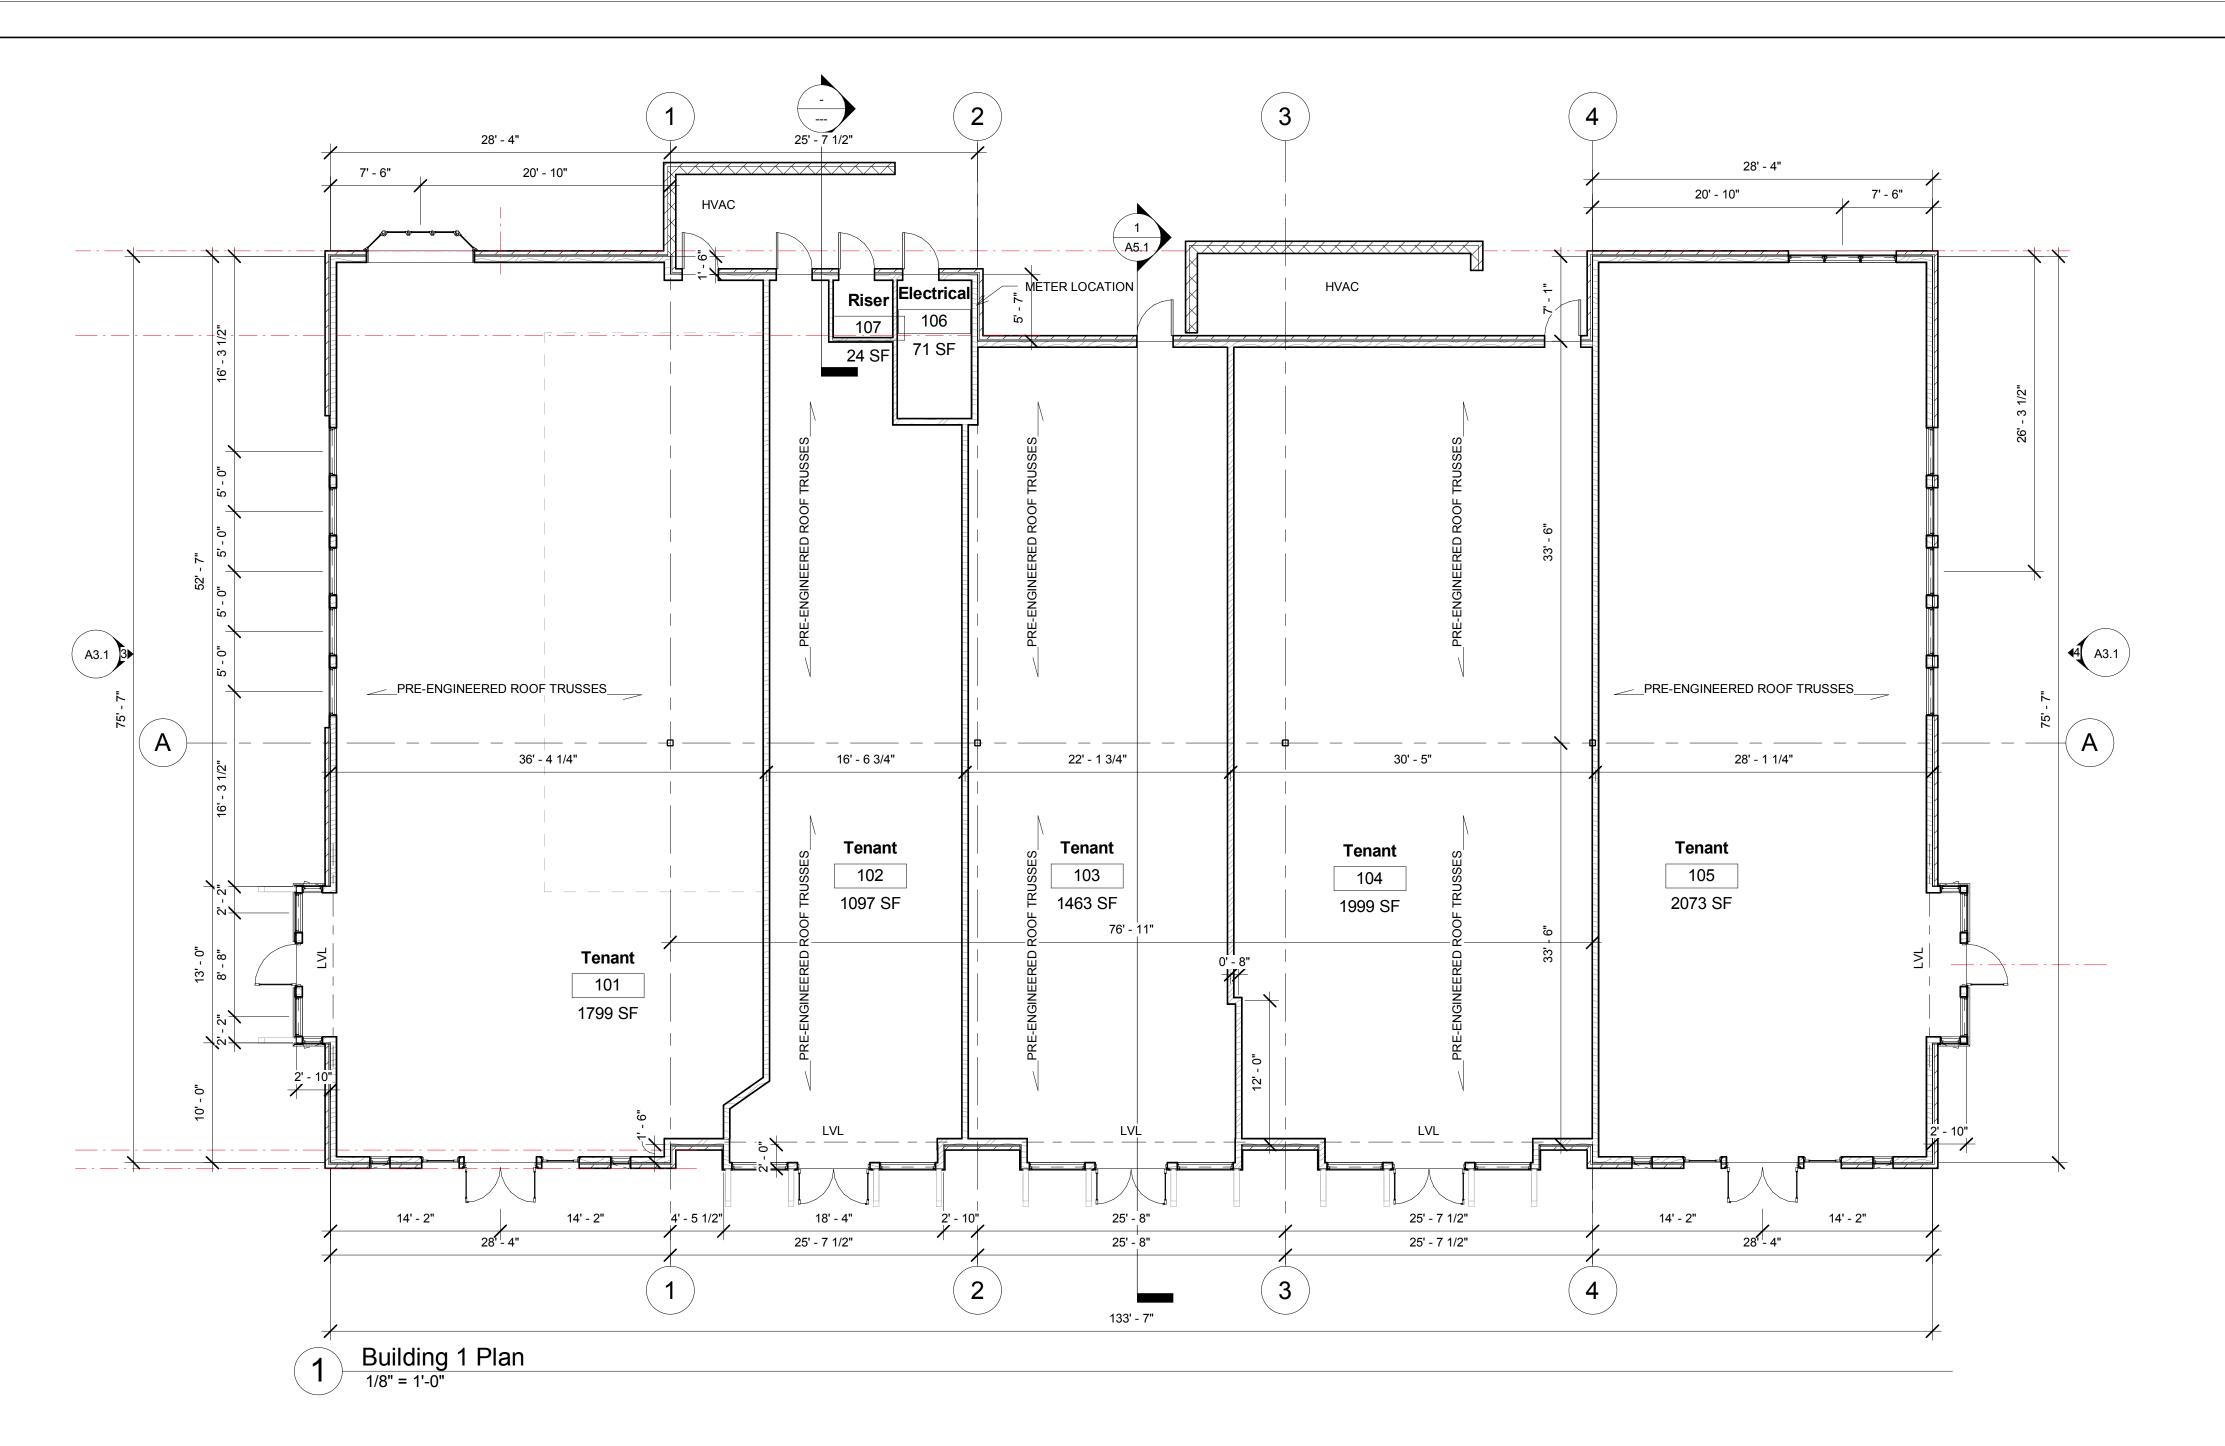
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17-041

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MEP PROGRAM REQUIREMENTS

Tenant Space	Area	Cooling	Power	H20
Building One				
10	1 2668 sf	15 Tons	400 Amp	2"
10	2 1100 sf	3 Tons	100 or 200 Amp	1"
10	3 1466 sf	5 Tons	200 Amp	1"
10	4 2001 sf	6 Tons	100 or 200 Amp	1"
10	5 2091 sf	7.5 Tons	400 Amp	1"
Building Two				
20	1 2599 sf	15 Tons	400 Amp	2"
20	2 1418 sf	5 Tons	200 Amp	1"
Building Three				
30	1 1004 sf	3 Tons	100 or 200 Amp	3/4"
30	2 860 sf	3 Tons	100 or 200 Amp	3/4"
30	3 860 sf	3 Tons	100 or 200 Amp	3/4"
30	4 860 sf	3 Tons	100 or 200 Amp	3/4"
30	5 1004 sf	5 Tons	100 or 200 Amp	3/4"

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NEW COMMERCIALS BUILDING FOR:
ROSS BRIDGE VILLAGE CENTER
Hoover, Alabama

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DESIGN SCHEMATIC

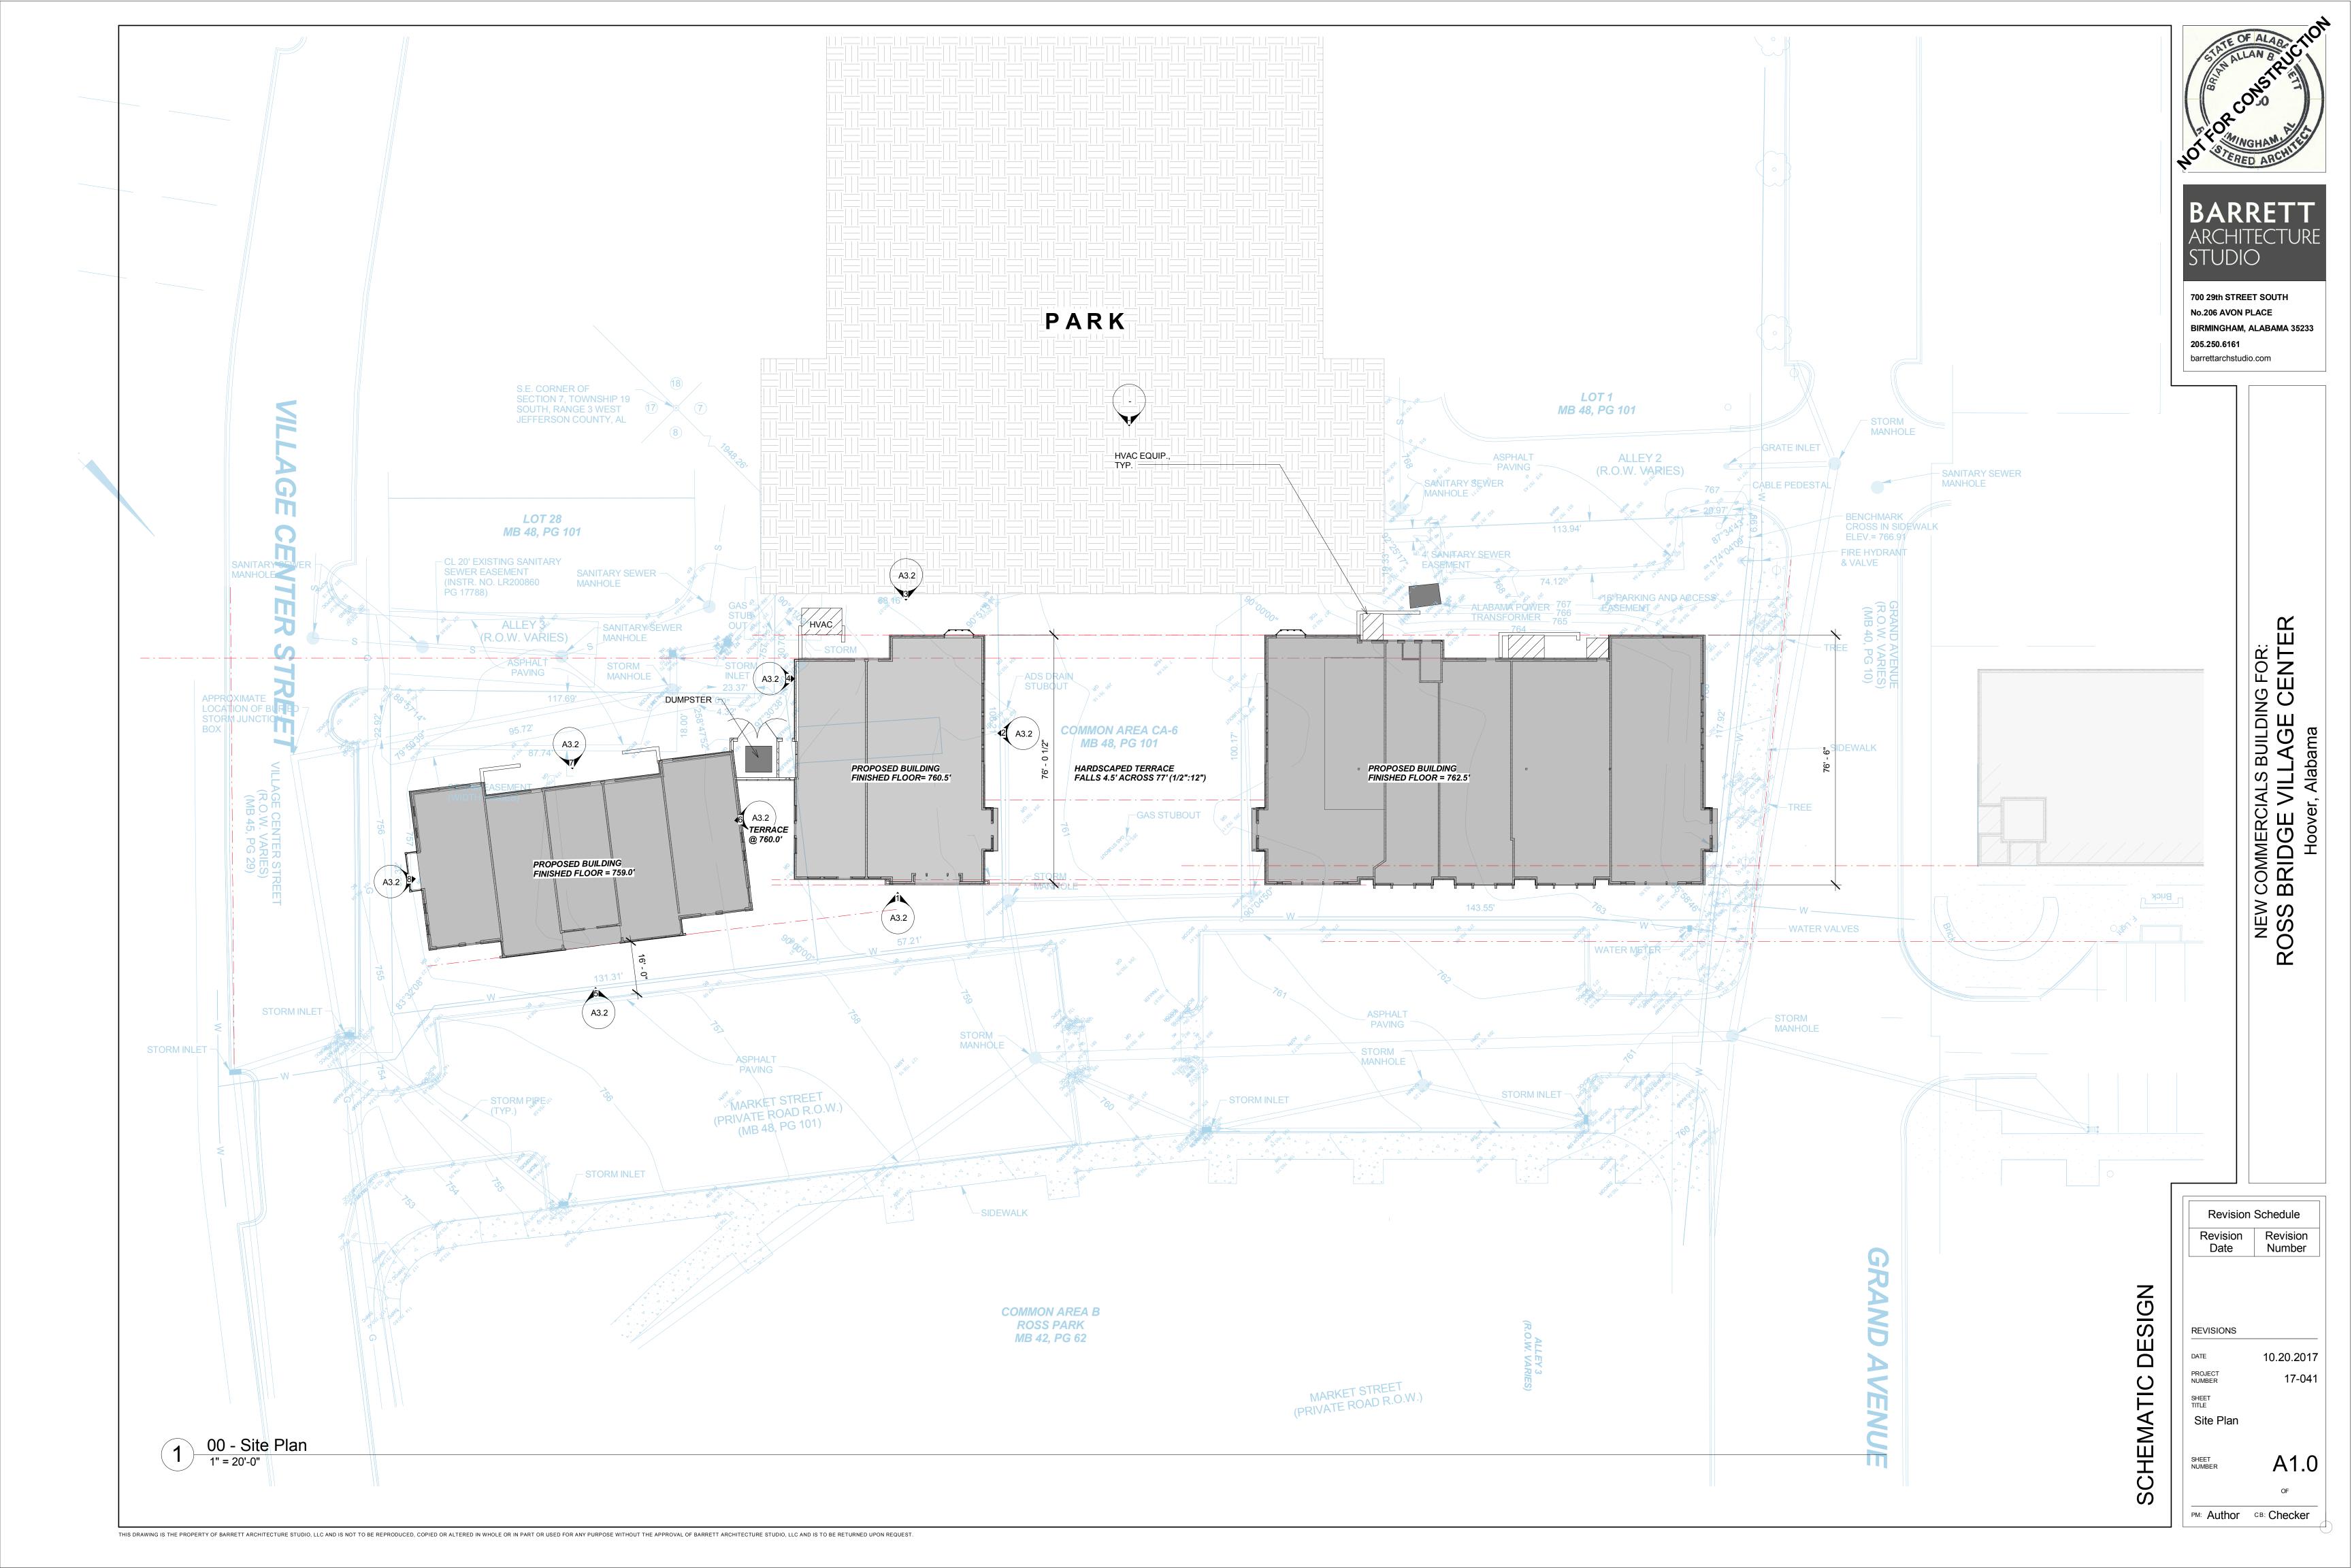10.20.2017

REVISIONS

Floor Plan Building 1

17-041

Revision Schedule

Revision Revision
Date Number


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Building 2 & 3 Plan
1/8" = 1'-0"

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Hoover, Alabama

Revision Schedule Revision Revision
Date Number

DESIGN

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REVISIONS DATE
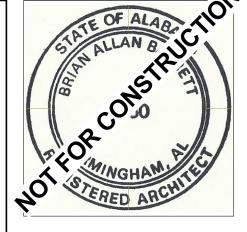
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Floor Plan Building 2 &

A1.2

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Hoover, Alabama

Revision Schedule
Revision Revision
Date Number

REVISIONS

DATE 10.20.2017
PROJECT 17.011

PROJECT NUMBER 17-041
SHEET TITLE

Roof Plan Building 1

A1.3


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A3.1



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Revision Schedule Revision Revision
Date Number DESIGN

REVISIONS

SCHEMATIC

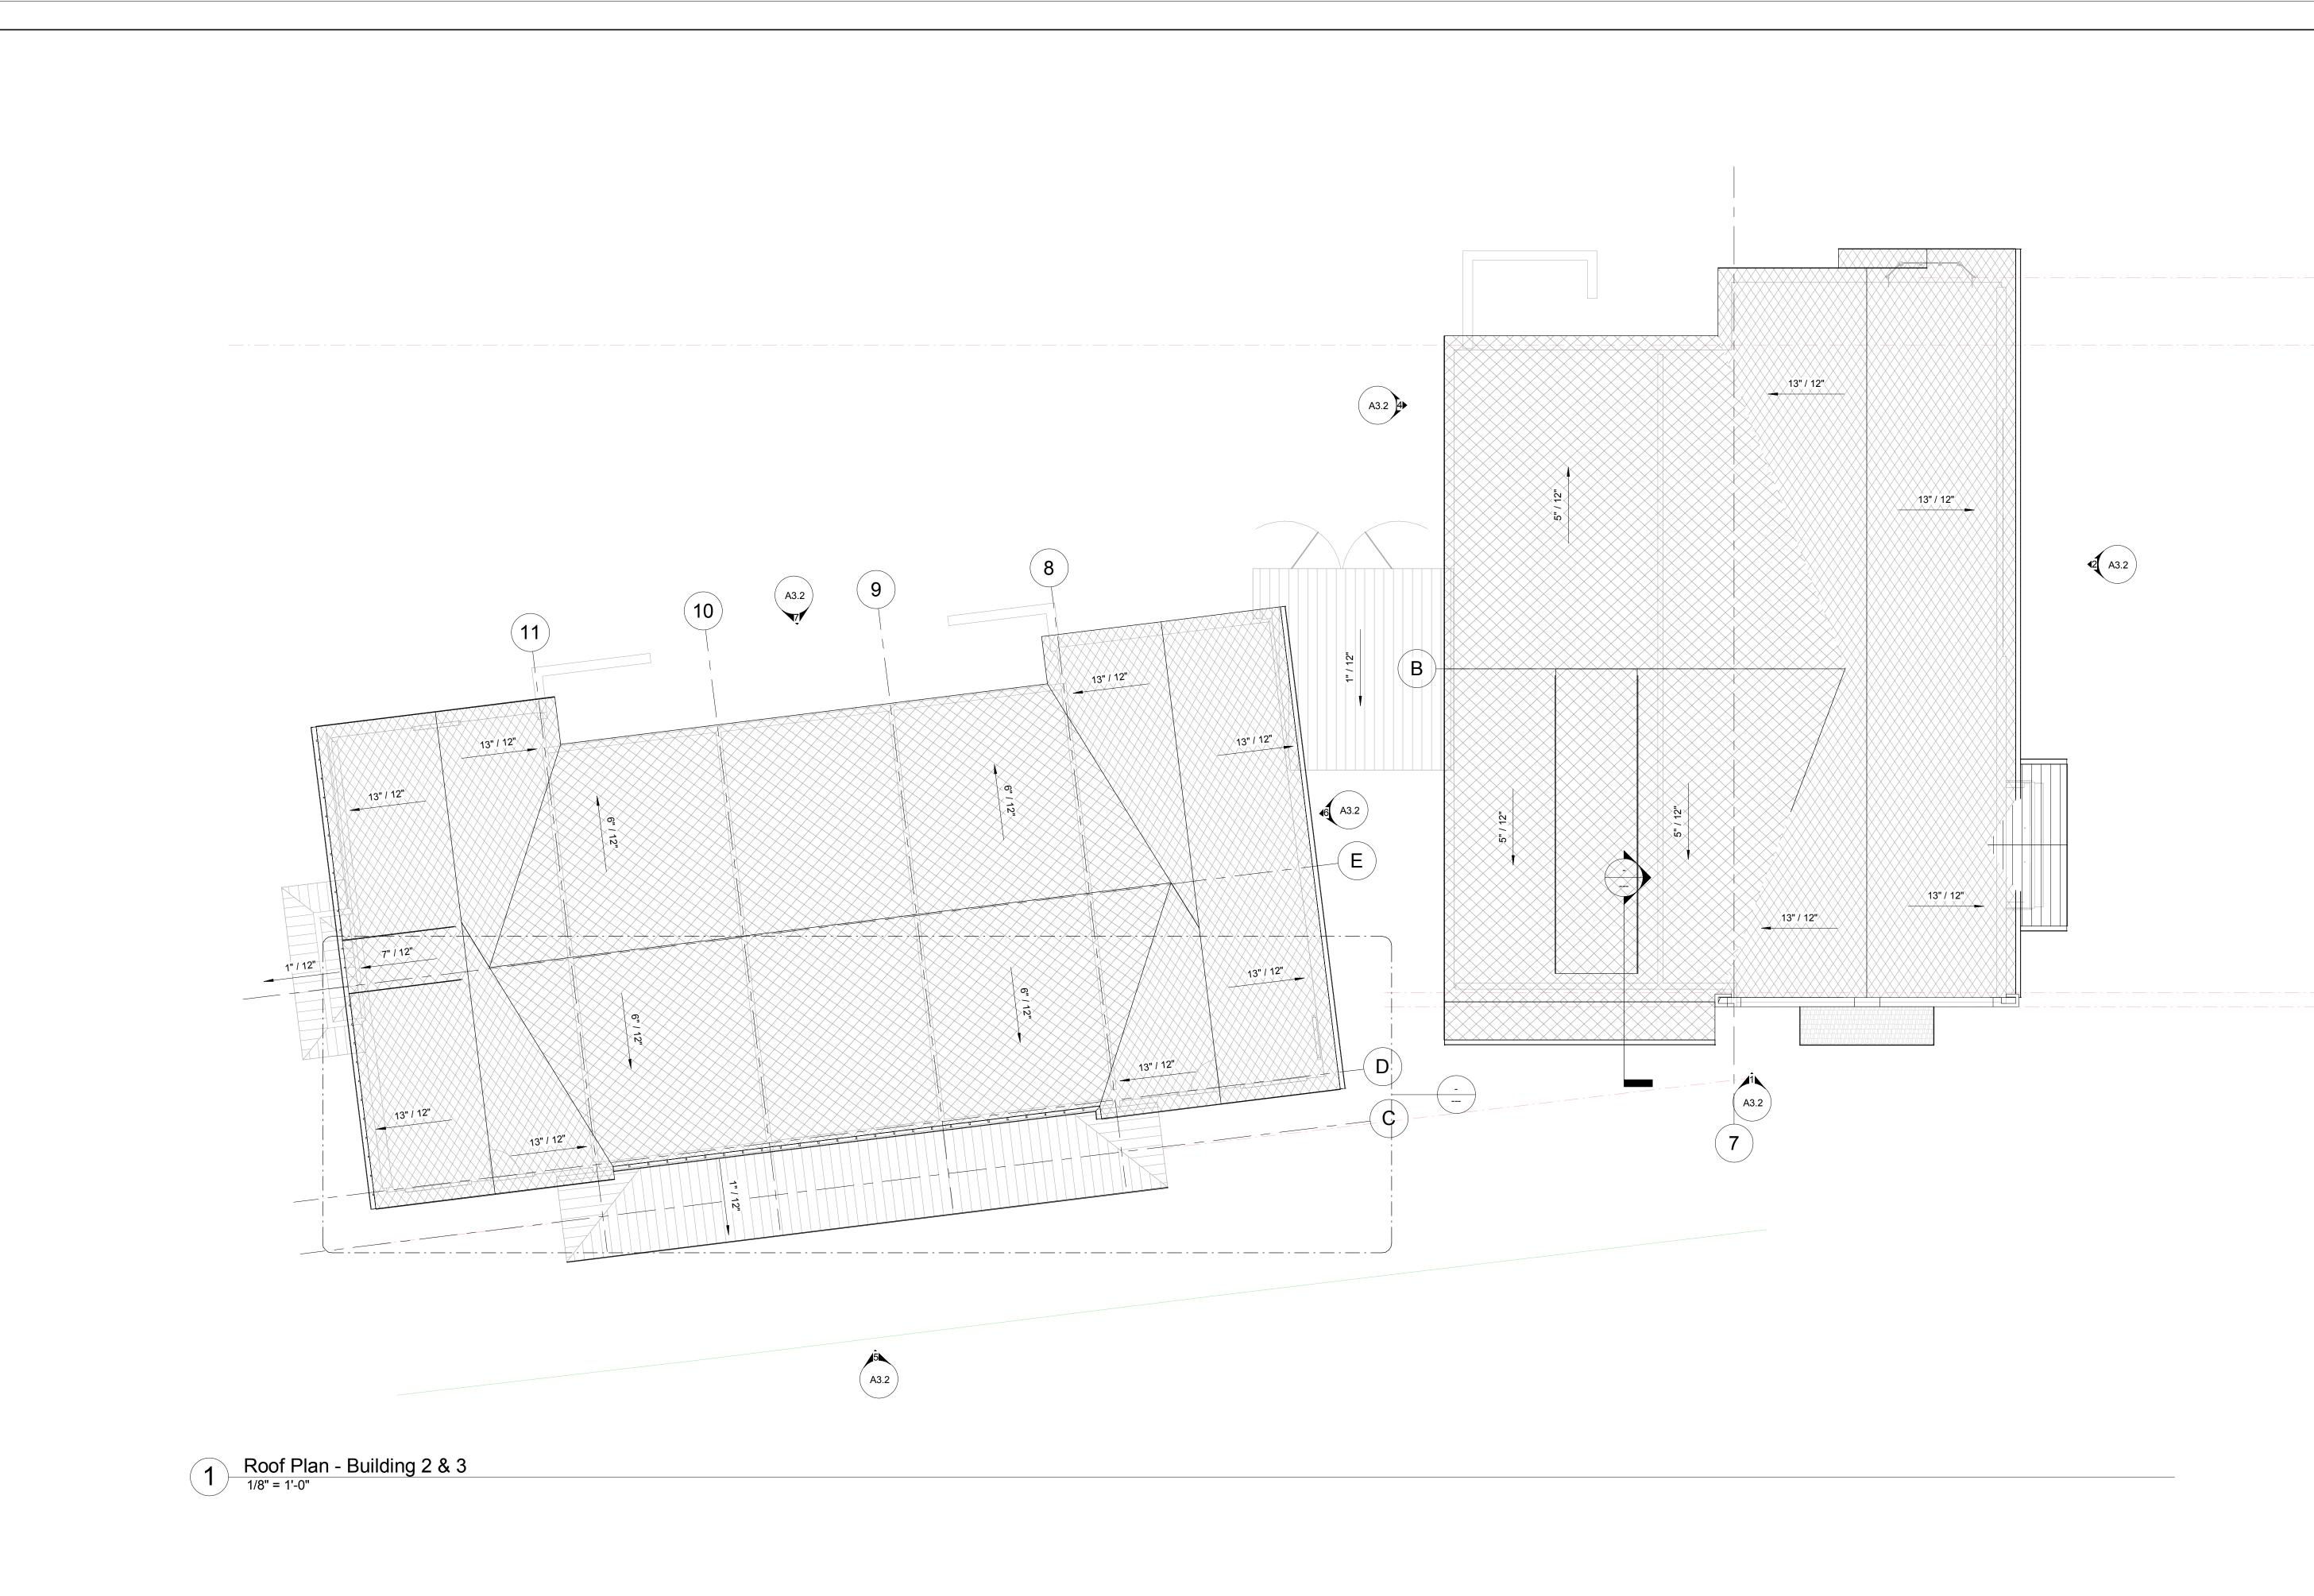DATE

10.20.2017 17-041

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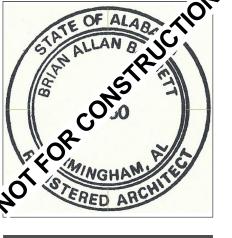
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NEW COMMERCIALS BUILDING FOR:
ROSS BRIDGE VILLAGE CENTER
Hoover, Alabama

Roof Plan Buildings 2 & 3

A1.4

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NEW COMMERCIALS BUILDING FOR:
ROSS BRIDGE VILLAGE CENTER
Hoover, Alabama

Revision Schedule Revision Revision Date Number


REVISIONS

10.20.2017 DATE PROJECT NUMBER 17-041

SHEET TITLE

Exterior Elevations

SHEET NUMBER A3.²

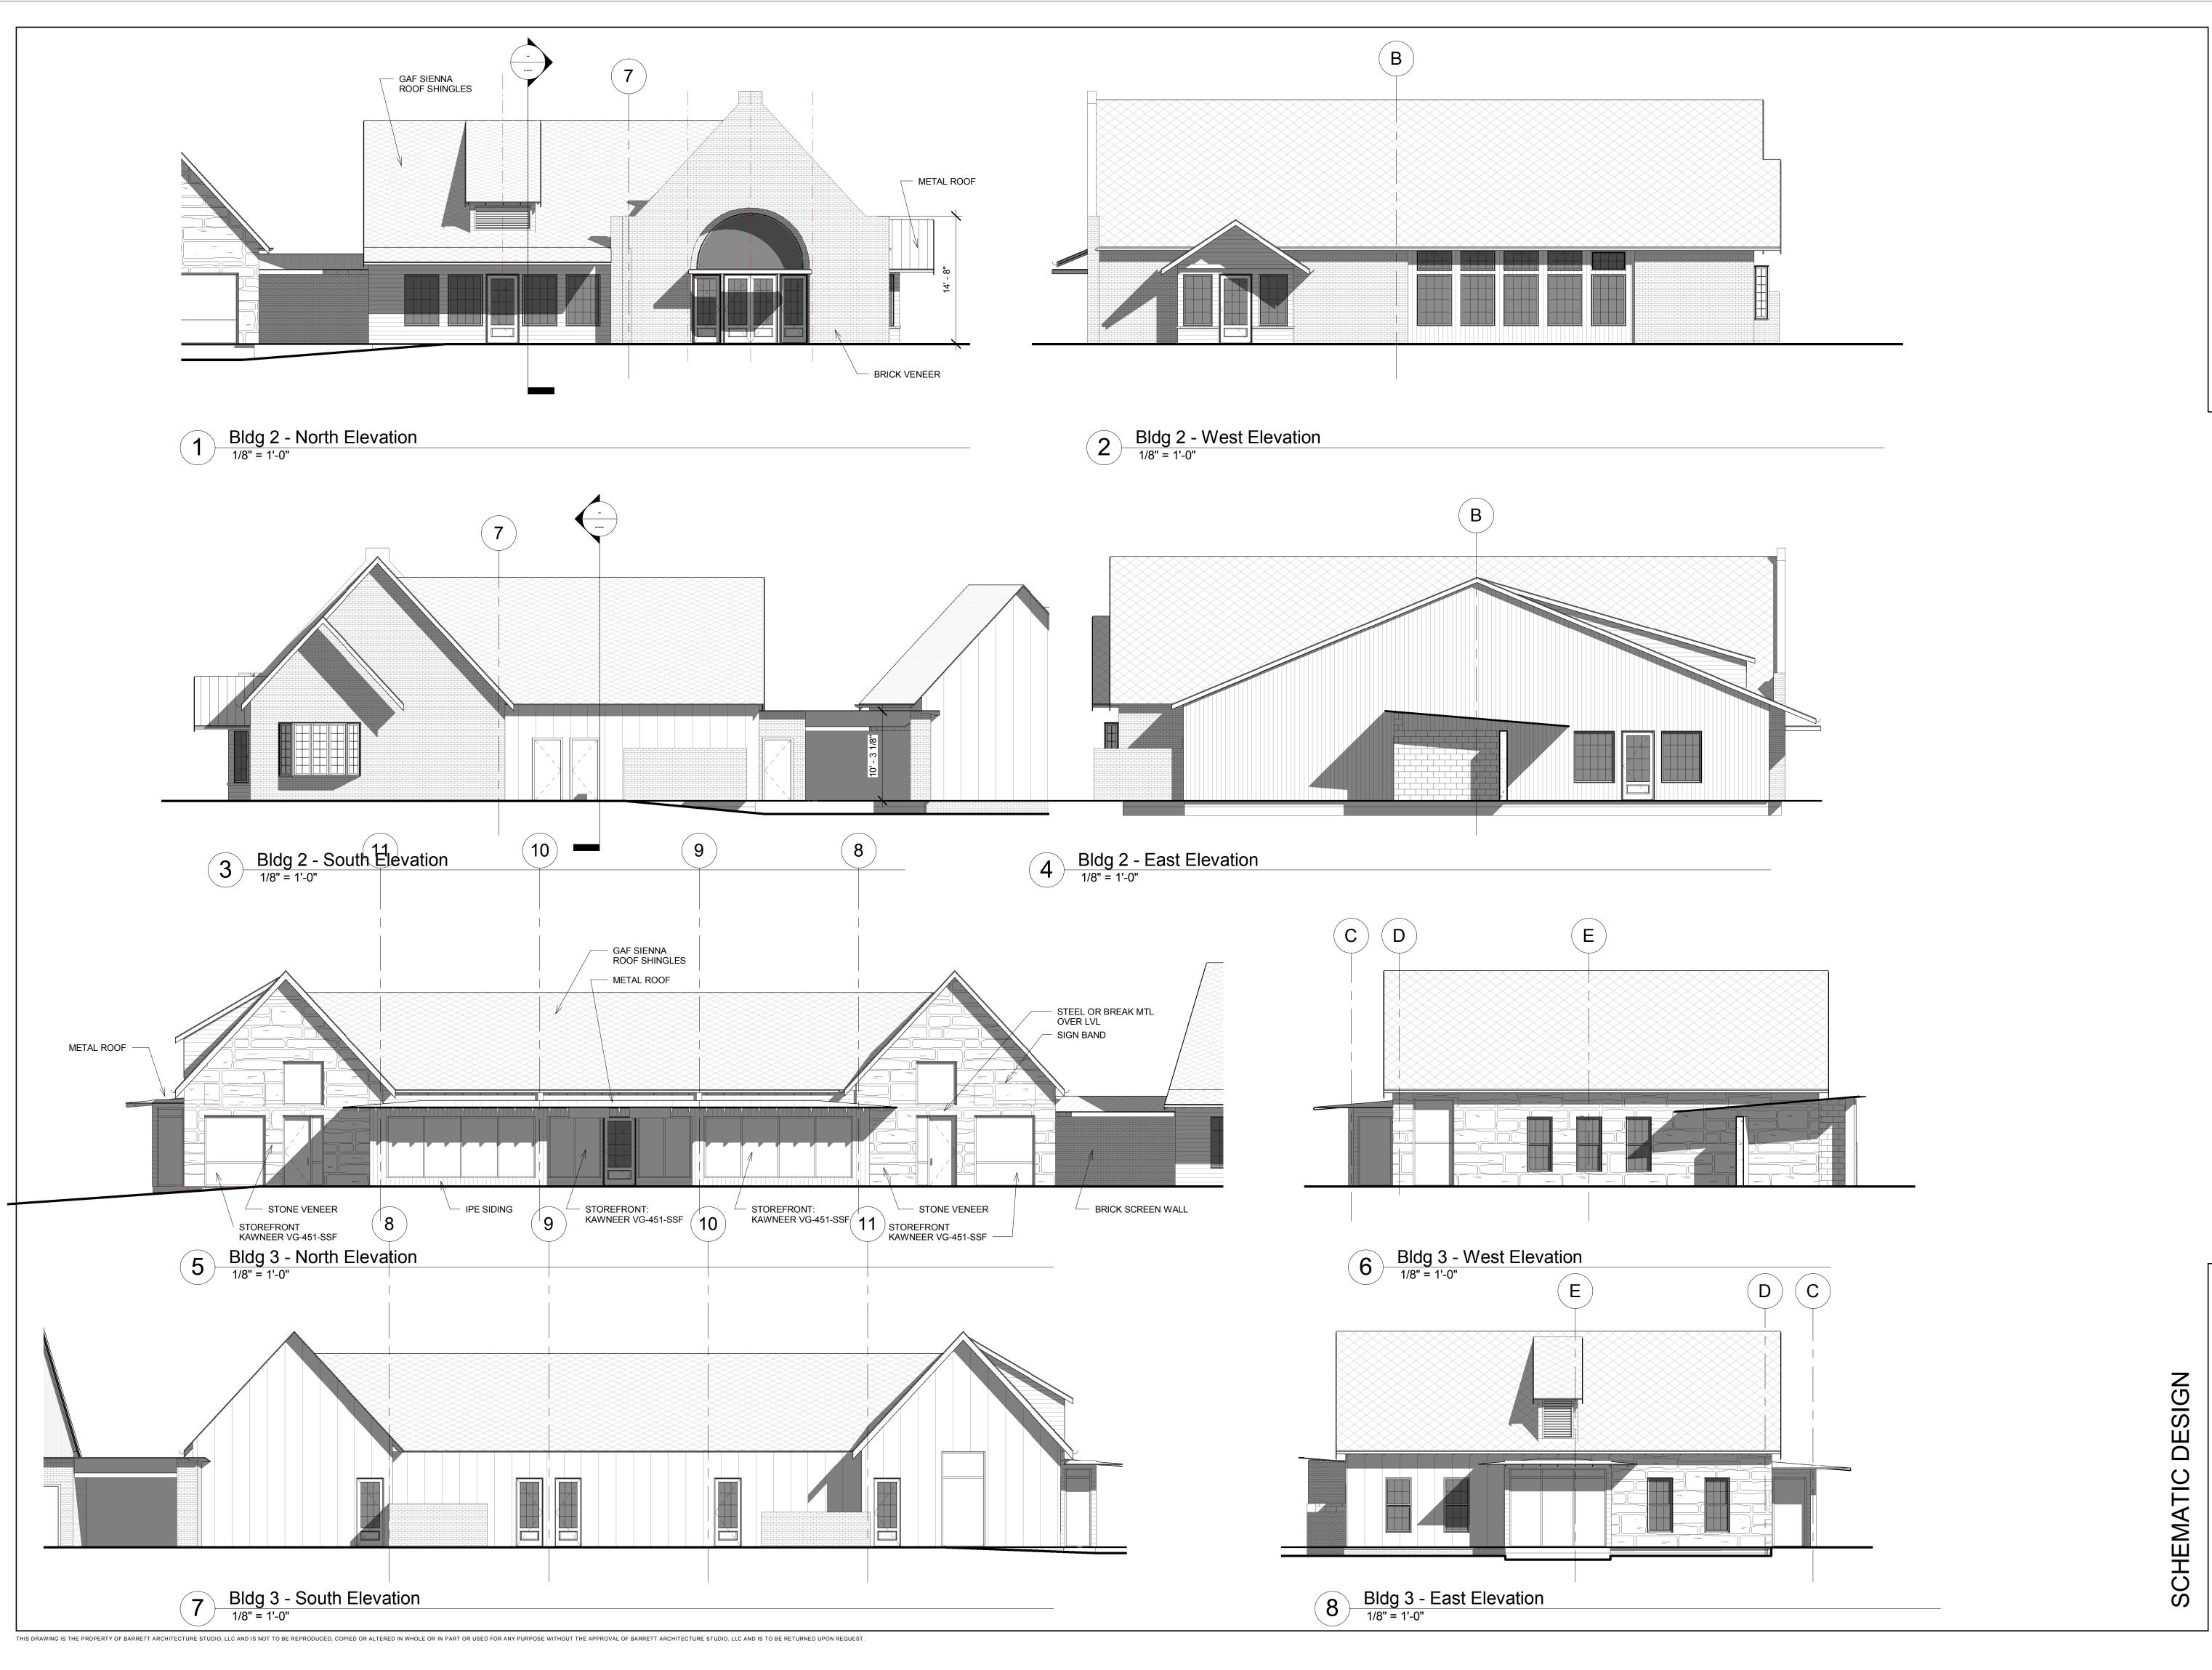



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PROJECT NUMBER 17-041 SHEET TITLE

Exterior Elevations

A3.2

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17-041

Wall Sections

A5.1

10.20.2017